



ATTACHMENT B
DRAWINGS

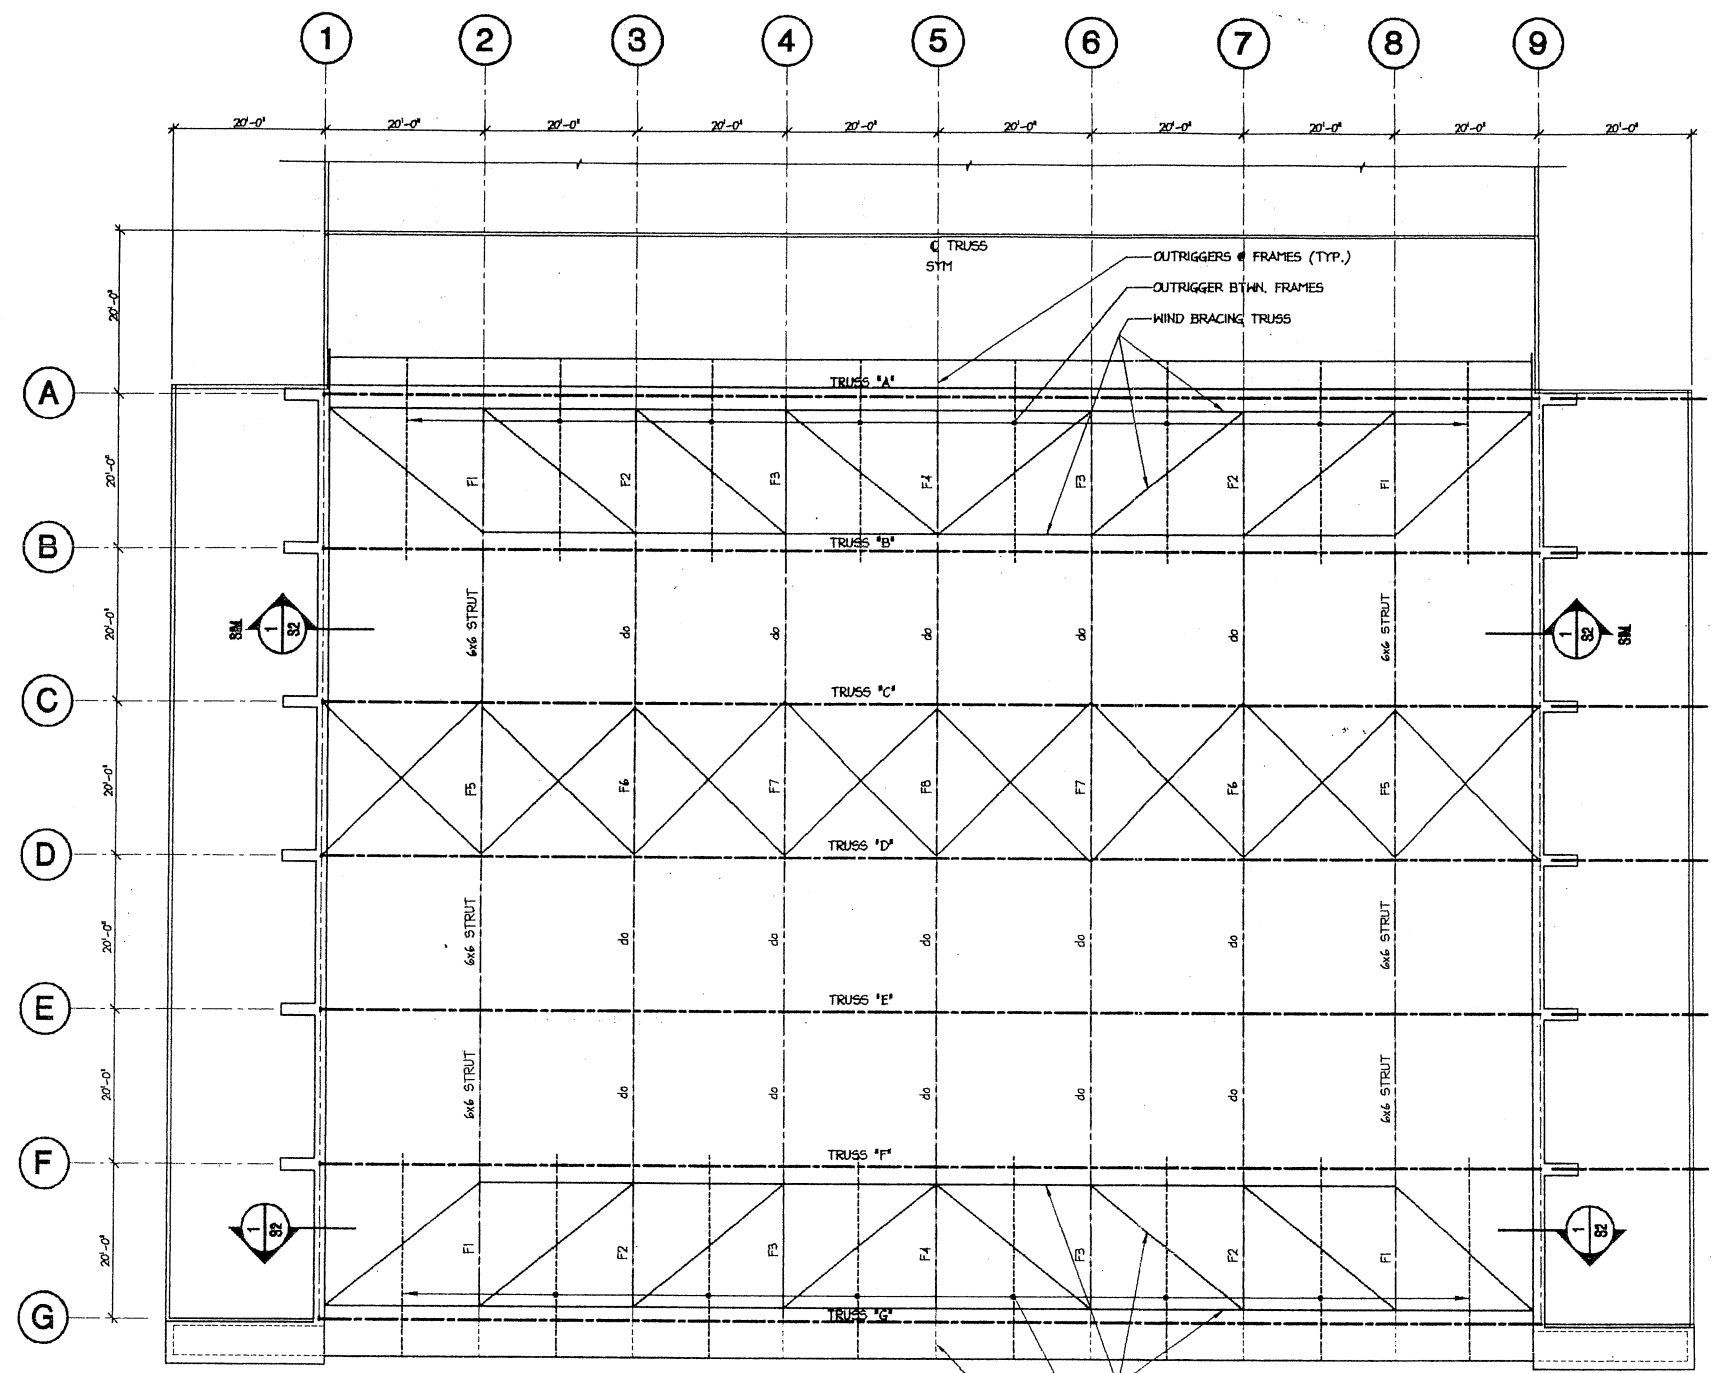


ROOF FRAMING PLAN - BUILDING #401
1/2" = 1'-0"


1. ALL INFORMATION SHOWN IS EXISTING.
2. SEE SHEET S2 FOR TYPICAL EXIST. TRUSS ELEVATION / CONFIGURATION & MEMBER IDENTIFICATION.

NO.	REVISION	DATE	BY

PROJ: 900945
 DRG: 051
 DRAWN: DRANNEN
 CHD: EDH
 DATE: 8-98

BUILDING #401
BUILDING STRUCTURAL ASSESSMENT
PART OF MOSES LAKE
 MOSES LAKE, WA

PACIFIC ENGINEERING & DESIGN
CONSULTING ENGINEERS
 7 NORTH WENATCHEE AVENUE, SUITE 405
 WENATCHEE, WASHINGTON 98857
 (509) 842-1951 FAX (509) 842-8327

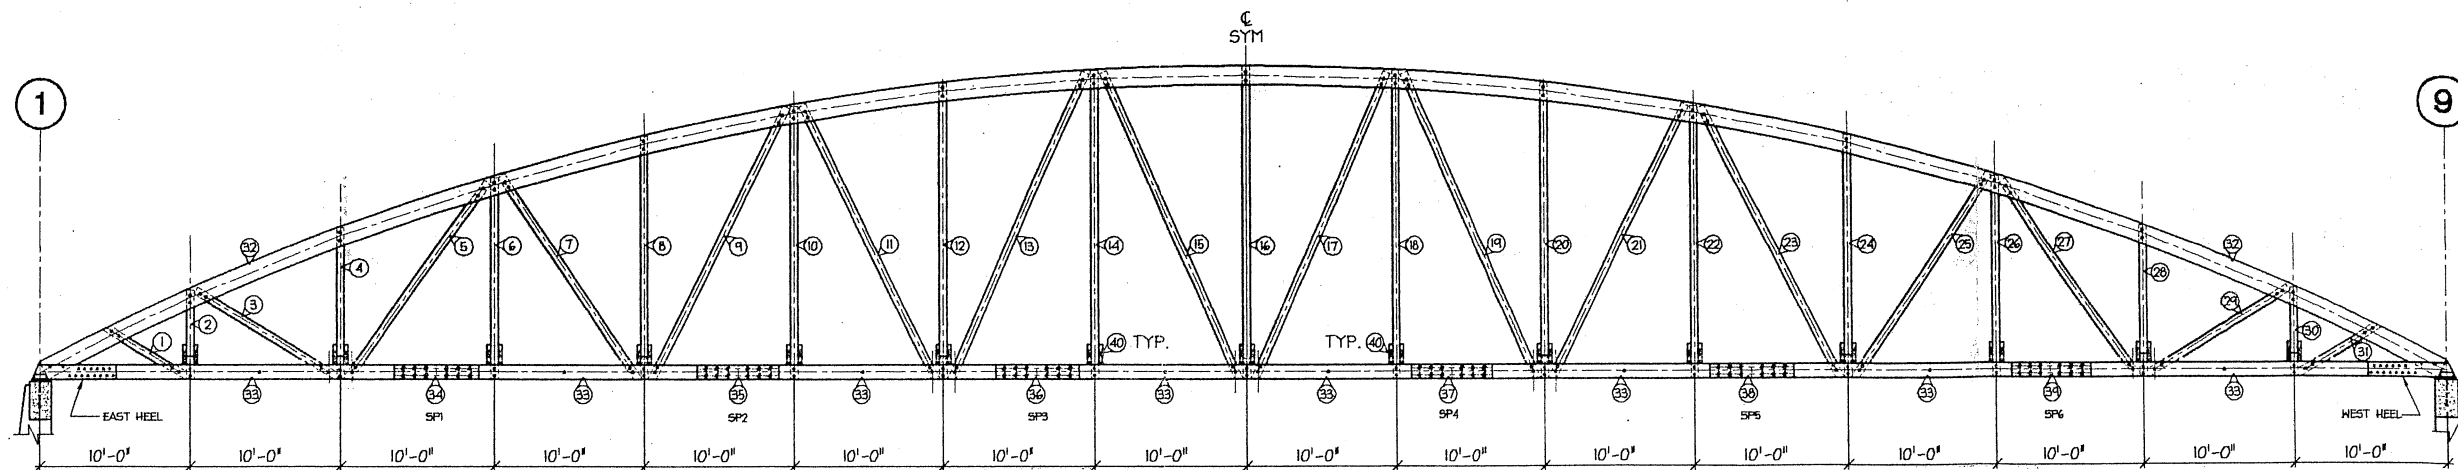

NOTES:
 1. TRUSS ELEVATION LOOKING SOUTH.
 2. SP# - CHORD SHOULD SPLICE FROM EAST TO WEST

TRUSS ELEVATION AND TABLE - BUILDING #401

TRUSS MEMBER IDENTIFICATION TABLE			
MARK	DESCRIPTION	MARK	DESCRIPTION
①	6x6 DIAGONAL MEMBER	②	6x6 DIAGONAL MEMBER
②	6x6 VERTICAL MEMBER	②②	6x6 VERTICAL MEMBER
③	6x6 DIAGONAL MEMBER	②③	6x6 DIAGONAL MEMBER
④	6x6 VERTICAL MEMBER	②④	6x6 VERTICAL MEMBER
⑤	6x6 DIAGONAL MEMBER	②⑤	6x6 DIAGONAL MEMBER
⑥	6x6 VERTICAL MEMBER	②⑥	6x6 VERTICAL MEMBER
⑦	6x6 DIAGONAL MEMBER	②⑦	6x6 DIAGONAL MEMBER
⑧	6x6 VERTICAL MEMBER	②⑧	6x6 VERTICAL MEMBER
⑨	6x6 DIAGONAL MEMBER	②⑨	6x6 DIAGONAL MEMBER
⑩	6x6 VERTICAL MEMBER	②⑩	6x6 VERTICAL MEMBER
⑪	6x6 DIAGONAL MEMBER	③①	6x6 DIAGONAL MEMBER
⑫	6x6 VERTICAL MEMBER	③②	(2) MULTIPLE 2x6 TOP CHORD*
⑬	6x6 DIAGONAL MEMBER	③③	(2) 6x12 BOTTOM CHORD
⑭	6x6 VERTICAL MEMBER	③④	(2) 3x12 SPLICE PLATES
⑮	6x8 DIAGONAL MEMBER	③⑤	(2) 3x12 SPLICE PLATES
⑯	6x6 VERTICAL MEMBER	③⑥	(2) 3x12 SPLICE PLATES
⑰	6x8 DIAGONAL MEMBER	③⑦	(2) 3x12 SPLICE PLATES
⑱	6x6 VERTICAL MEMBER	③⑧	(2) 3x12 SPLICE PLATES
⑲	6x6 DIAGONAL MEMBER	③⑨	(2) 3x12 SPLICE PLATES
⑳	6x6 VERTICAL MEMBER	④①	(2) 3x14 OUTRIGGERS


* - GLU LAMINATED [(10) 2x6]

DATE	BY

PROJ: 900105
 DWG: 4782
 DRAWN: DRW: NED
 CHECK: RCH
 DATE: 5-13-98

BUILDING #401
 BUILDING STRUCTURAL ASSESSMENT
 PORT OF MOSES LAKE
 MOSES LAKE, WA.

PACIFIC ENGINEERING & DESIGN
 CONSULTING ENGINEERS
 7 NORTH WENATCHEE AVENUE, SUITE 405
 WENATCHEE, WASHINGTON 98801
 (509) 662-1981 FAX (509) 662-8227

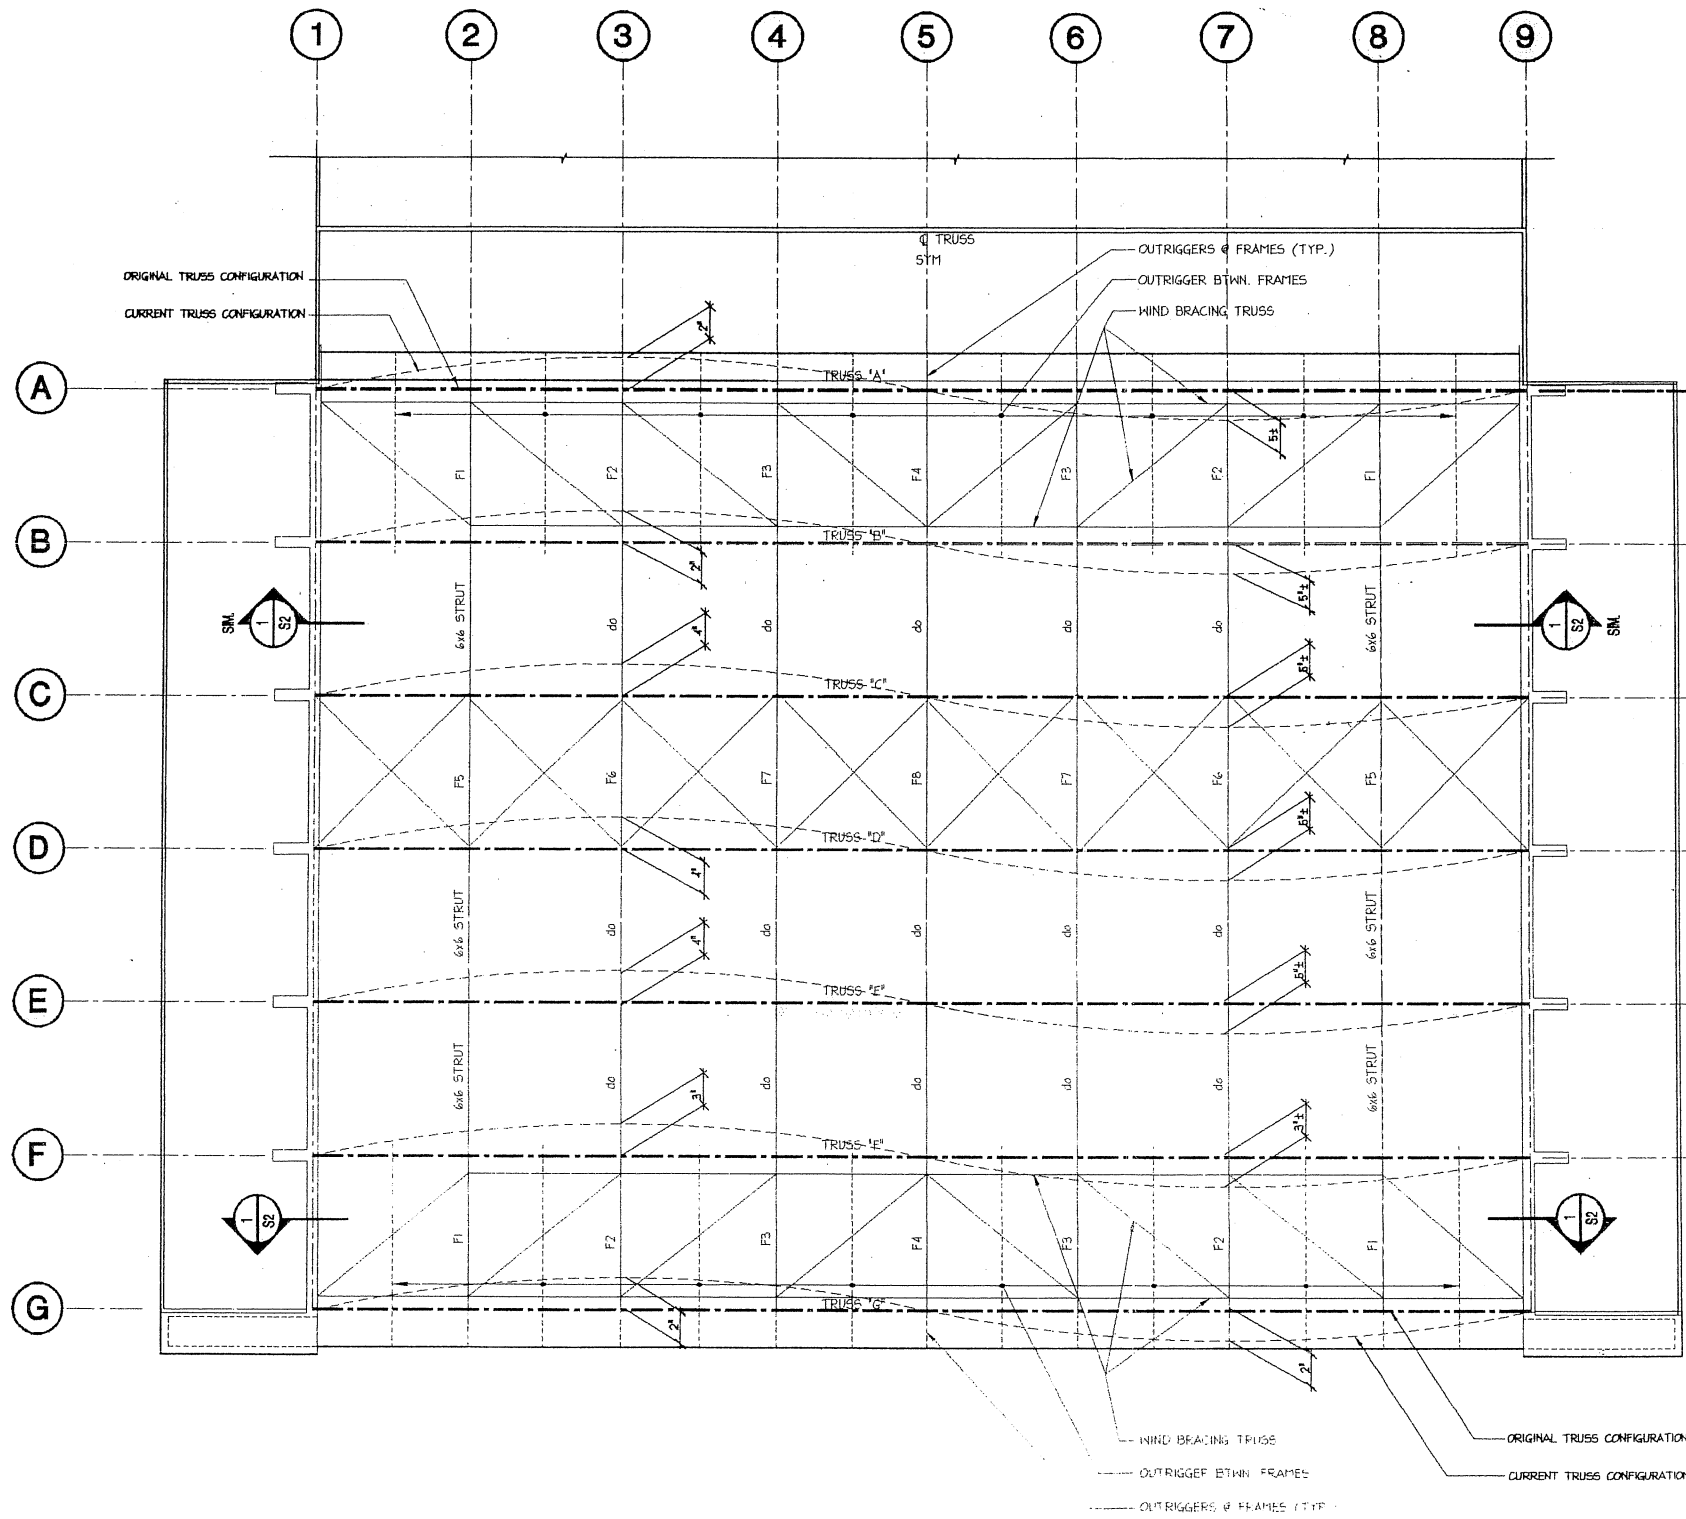

ROOF FRAMING PLAN - BUILDING #401 - SKEWED CONFIGURATION OF CURRENT CONDITION OF TRUSSES


1. ALL INFORMATION SHOWN IS EXISTING.
2. SEE SHEET S2 FOR TYPICAL EXIST. TRUSS ELEVATION / CONFIGURATION & MEMBER IDENTIFICATION.

NO.	REVISION	DATE	BY

PROJ: 080145
 DWG: 405
 DRAWN: CHD:RDH
 CHECK: RDH
 DATE: 5-18-10

BUILDING #401
BUILDING STRUCTURAL ASSESSMENT
PORT OF MOSES LAKE
 MOSES LAKE, WA.

PACIFIC ENGINEERING & DESIGN
CONSULTING ENGINEERS
 7 NORTH WENATCHEE AVENUE, SUITE 405
 WENATCHEE, WASHINGTON 98801
 (509) 665-1161 FAX (509) 665-0327

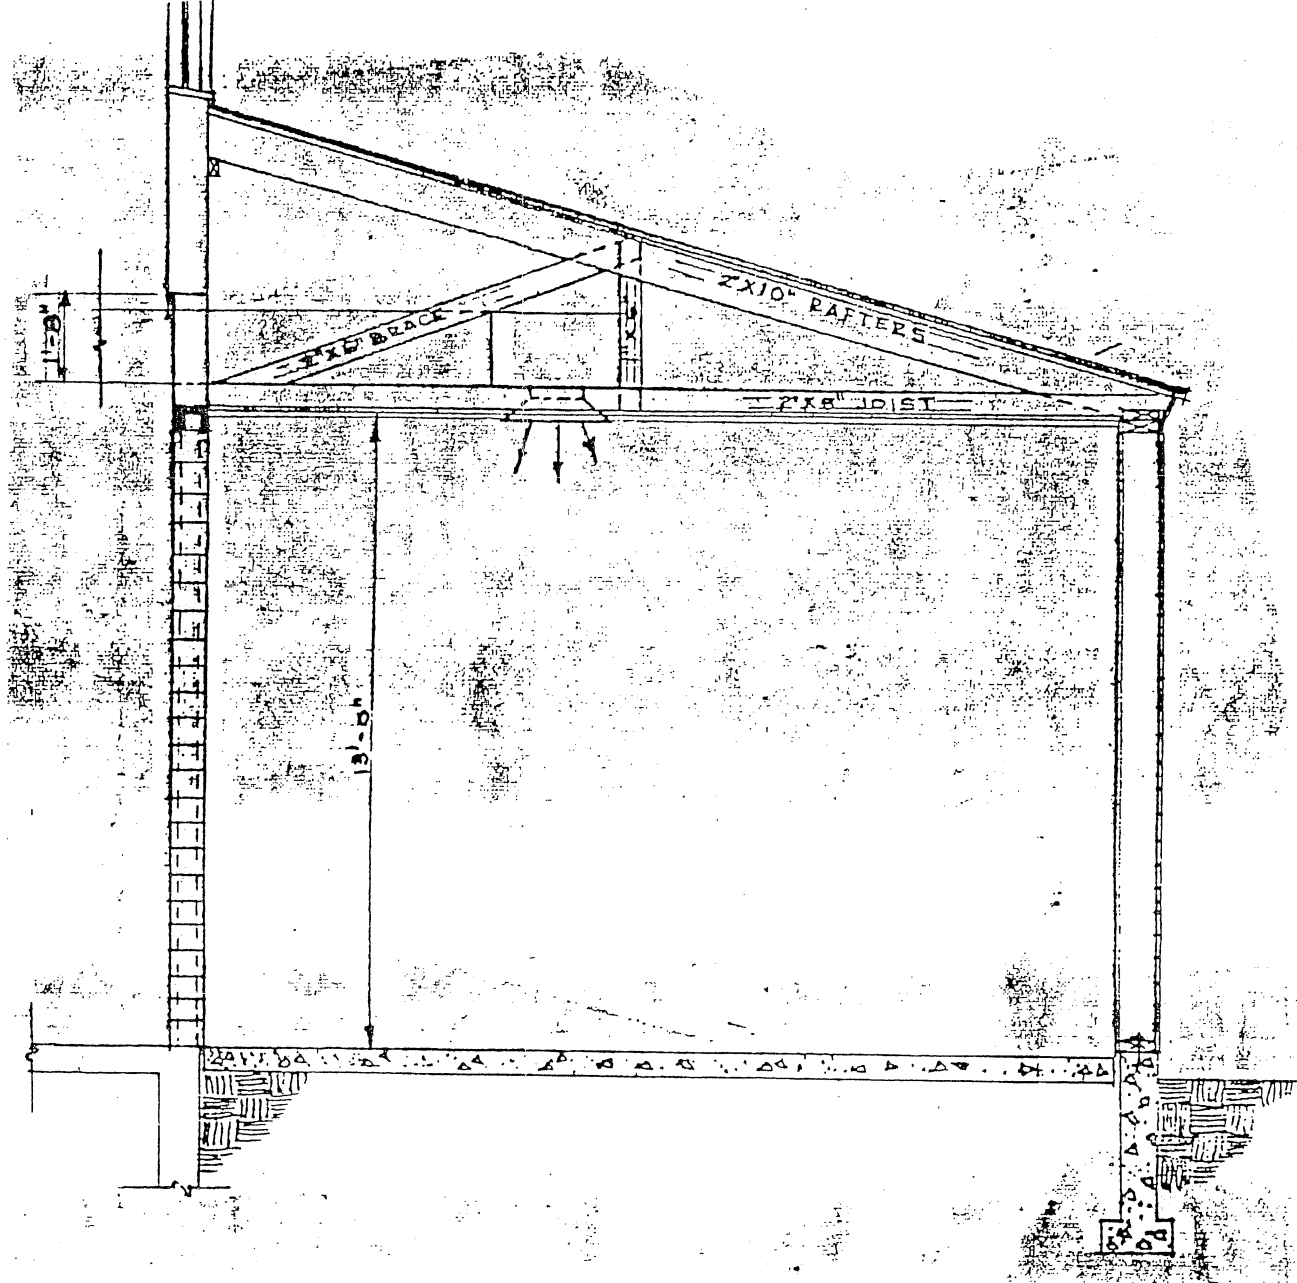

BUILDING SECTION - LEAN-TO STRUCTURE
ETA

NO.	REVISIONS	DATE	BY

PROJ: 900945
 DWG: 4085
 DRN: NHA
 CRD: RDH
 DATE: 5-19-95

BUILDING #408
 BUILDING STRUCTURAL ASSESSMENT
 PORT OF MOSES LAKE
 MOSES LAKE, WA

PACIFIC ENGINEERING & DESIGN
 CONSULTING ENGINEERS
 7 NORTH WENATCHEE AVENUE, SUITE 408
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 (509) 662-1101 FAX (509) 662-8227